



Second Floor Plan Scale 1:100

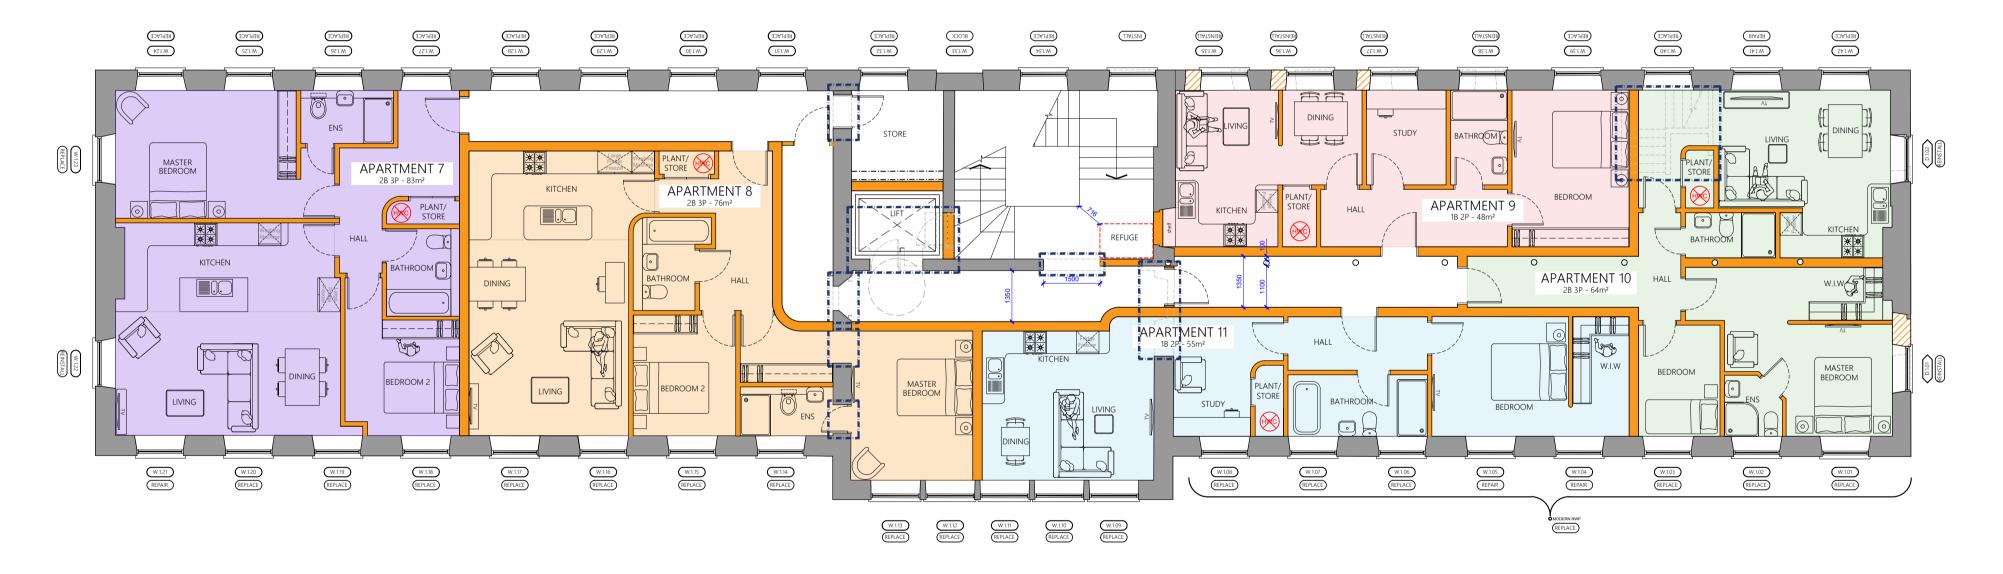


First Floor Plan Scale 1:100

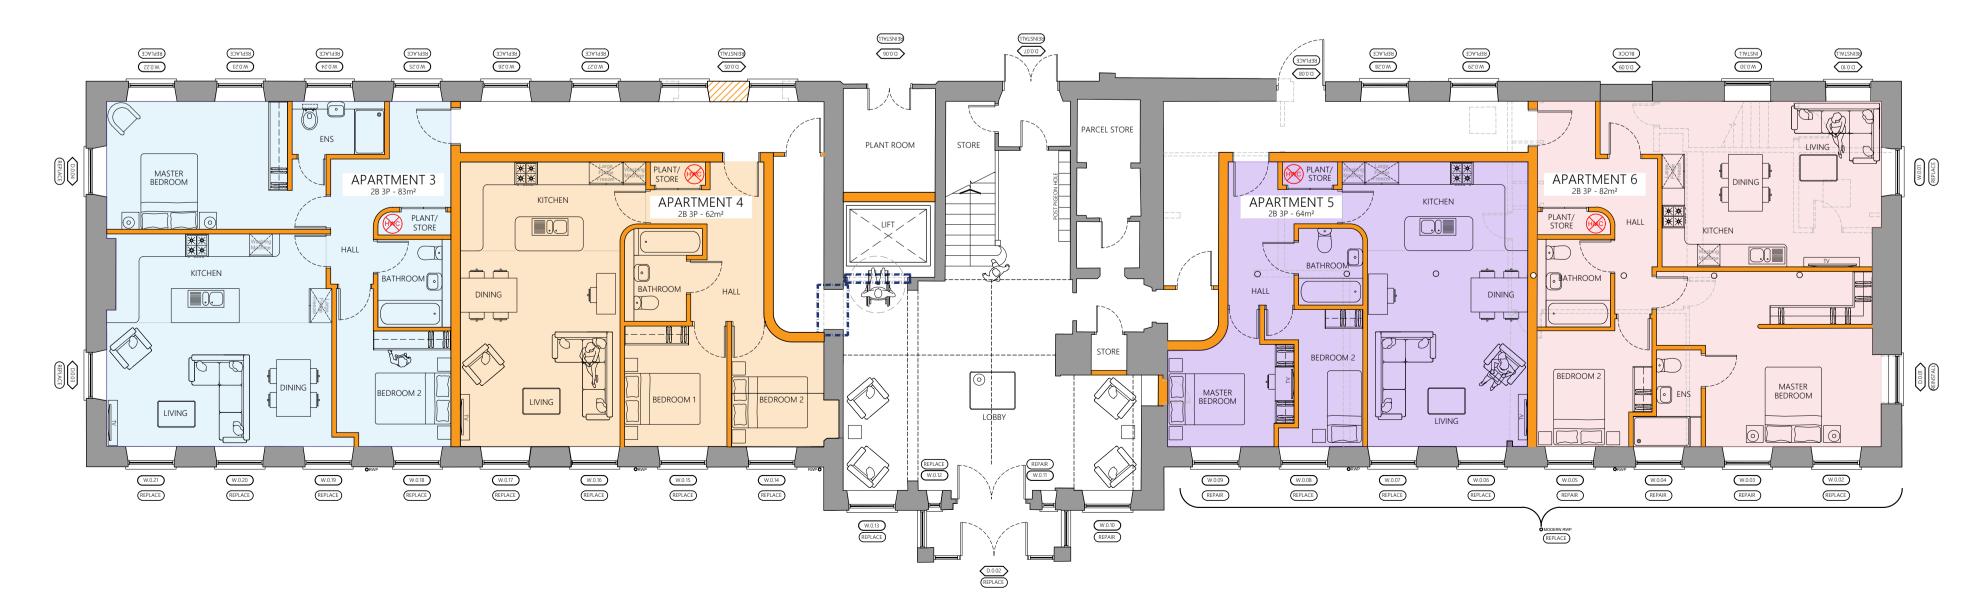

Ground Floor Plan

Scale 1:100

ACCOMMODATION MIX				
FLOOR	ACOMMODATION	ROOMS	GIA/m²	
0F (Stables)	Apartment 1	2B 3P	109	
1F (Stables)	Apartment 2	2B 3P	109	
0F	Apartment 3	2B 3P	83	
0F	Apartment 4	2B 3P	62	
0F	Apartment 5	2B 3P	64	
0F	Apartment 6	2B 3P	82	
1F	Apartment 7	2B 3P	83	
1F	Apartment 8	2B 3P	76	
1F	Apartment 9	1B 2P	48	
1F	Apartment 10	2B 3P	64	
1F	Apartment 11	1B 2P	55	
2F	Apartment 12	2B 3P	83	
2F	Apartment 13	2B 3P	76	
2F	Apartment 14	1B 2P	50	
2F	Apartment 15	2B 3P	60	
2F	Apartment 16	1B 2P	61	
TOTAL APARTMENTS		16	1,165	
TOTAL BEDS		28		

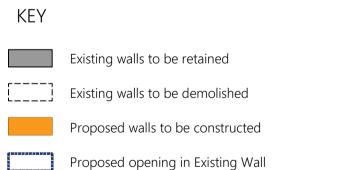

original properties.

Proposed external wall to be rebuilt to match

All internal walls to be assessed by Structural Engineer to establish required supports for removal. All demolition to Structural Engineer's details.

NOTE
Kitchen unit layout is for indicative reasons ONLY and is subject to specialist design and confirmation from

NOTE
Services passing through any compartment wall/floor are to be fire stopped with fire dampers and boxed in with 2no. layers of fire resistant plasterboard and mineral wool to provide sufficient acoustic reduction.

NOTE
Drainage proposals are indicative only and subject to confirmation on site following investigation by the Contractor. Contractor responsible for locating any existing drainage services on site and creating new connections accordingly. All proposed drainage works are to be carried in accordance with BS EN 1610:2015 and Approve Document H1:2010. Suggested new connections to be agreed on site with Building Control

Scale Bar 1:100



Proposed Works To Fuchs Site, Brooke Close, Belper, Derby

Proposed Floor Plans

21,034-P-102

CALE	DRAWN BY
:100 @ A1	JA, JP
RAWING NUMBER	



Contractor responsible for verifying layouts on site. Notify the Architect of any discrepancies prior to work commencing on site.

Contractor responsible for locating all existing drainage and services on site and creating new connections accordingly.

Foundations, floor structure, steel lintels, etc... are to be in strict accordance with Structural Engineer's drawings. Existing construction details are assumed from survey information and photographs and are to be confirmed on site by the contractor following strip out prior to the

project commencing. Proposed floor levels are to be confirmed on site and are to line through with existing Finished Floor Levels unless otherwise stated. Existing FFIs are taken from survey information provided by others and are to be confirmed

If the contractor is any doubt ask the Architect.